

#### **ADDENDUM #5**

## Will County Health Department BID PACKAGE #2 – Misc. Steel/Structural/Enclosure November 15, 2018

This addendum will be included in all future sets of drawings distributed and on the Leopardo Building Connected website.

Division 1 – General Instructions

#### **1.0 Bid Instructions**

#### A. Bid Submission

1. There will be NO bid due date extension for this addendum. Final bids are due no later than 1:00PM on Tuesday, November 20, 2018.

#### 1.1 Bid Documents

#### A. Schedule of Bid Documents

The following documents are included as part of this bid addendum:

DATE	DESCRIPTION	By
11/15/18	Addendum Narrative (this document) - FOLLOWS – 1 Page	Leopardo
		Companies
11/15/18	Bid RFI Log Dated 11/15/18 – 8 Pages	Leopardo
		Companies
11/13/18	Revisions Narrative and Drawing Index – 3 Pages	Kluber
11/13/18	Specification Sections Revisions 11/13/18 (As Listed Below) –	Kluber
	2 Pages	
11/13/18	Drawing Revisions (As Listed Below) – 10 Pages	Kluber

#### 2.0 General Information

#### A. Revised Specification Sections – Dated 2018.11.13

- 072500.02 Weather Barriers
- 078100.02 Applied Fireproofing

#### B. Revised Drawings Sheets - Dated 2018.11.13

- A330
- A501
- A600
- A1000
- A1001
- A1202
- A1203
- A1204
- S321
- S500

**END OF ADDENDUM #5** 

					Resolved
				P =	Pending Response
				l =	Incomplete
RFI#	ADDENDUM #	Question	Response		Status
BP2-001	Addendum #1	S311 states for top of footing elevations is to be at 96'-6" This is a 1' thick footing minimal which would put the bottom of footing an extra 1' 0" below what is required at 42". The note should read top of footing 2'-6" because our bottom of footing by code and their notes only needs to be 96'-6". The location for his coverage comment can be found pm S011 Note F9.	The note on S011 is in absent of other information. Other factors that drive this elevation are as follows:  1. The exterior grades typically are not flush with the interior slab on grade elevation. Variations occur and we do not run with the bare bones to avoid any frost coverage issues. This is our office standard and we will maintain as we are the EOR for the project.  2. We also have moment frames which have anchor rods that require correct embedment which is measure from the top of piers which are typically 8" below the finished floor. We maintain the embedment length of the bolts within the pier height so the bolts are not set in the footing.		R
BP2-002	Addendum #1	What is note 5.531 on S600 depicting?	Will be addtressed by addendum		R
BP2-003	Addendum #1	On G301 there is a table with 0 hour rating for floors and roofs. Next to the 0 hour note it identifies Stairs and shafts, elevator equipment room, and boiler room with 1 hour rating. It appears the fireproofing will be limited to all shafts, and stairs plus a couple mechanical rooms. With a note on the structural drawing that states all roof decks that require fireproofing will be galvanized. Will the roof decking at the top of the stairs and shafts require fireproofing?	No. Roof decking does not require a rating.		R
BP2-004	Addendum #1	Are Vehicle Restraints required with the Scissor Lift equipment?  These are stated in specification section 111319.02.	No. Paragraph 1.01 B will be removed by Addendum.		R
BP2-005	Addendum #1	Specification Reference 075300.02: Solar reflectance requirement of Elastomeric Membrane Roofing System is unattainable with a black membrane. Please advise.	Paragraph 2.02B1 will be eliminated by Addendum. SRI is not applicable with a black EPDM membrane.		R

BP2-006	Addendum #1	Membrane Roofing Scope of Work 4.e. states "All metal flashings and roof related sheet metal shall be prefinished per specs under this contract. Type and color of finish shall be as specified." What Flat Stock is the Metal Panel Subcontractor providing?	The Metal Panel Subcontractor is providing Flat stock for copings, metal fascia, soffits, gravel stops, downspouts, scuppers, conductor heads, and overflows to the Roofing subcontractor to furnish and install. All other metal flashings and roof related sheet metal for a complete roofing system must be provided by the Roofing Subcontractor.	R
BP2-007	Addendum #2	Please advise on the following Membrane Roofing questions: 1.) Is the vapor barrier being installed over the metal deck areas or just the concrete deck area.  2.) Is the insulation to be fastened into the vapor barrier or installed in adhesive so there is no penetration into the vapor barrier.  3.) It also states to run vapor barrier up parapet walls and underneath wood blocking, we cannot adhered directly to the vapor barrier so should we turn vapor barrier up a few inches to seal.	Metal and concrete areas. 2) Insulation shall be glued at the concrete roof deck areas and can be screwed at the metal deck areas thorugh the vapor barrier. 3) Spec Section 07 53 00.02 Paragraph 3.03A will be revised by Addendum #2 to clarify this issue.	R
BP2-008	Addendum #2	Do all anchor bolts receive galvanizing? (Sheet S321, note 2.g in Column Schedule).	Yes	R
BP2-009	Addendum #2	The screenwall girts have cap channels of different depths (12" and 15"). Please verify this is correct.	Yes	R
BP2-010	Addendum #2	Please verify roof height of canopy. Roof plan sheet A330 lists height at 129'-8" while the architectural drawing shows canopy height at 116'-2".	Will be addtressed by addendum #2.	R
BP2-011	Addendum #2	Please confirm/provide clarification for note 5.526, L3x3x1/4" galvanized angle and 3/A100 Please confirm what is needed at the loading dock/who is providing it.	It is a galvanized angle as indicated on Structural Sheet S312S per Keynote 5.526. The angle is at the full interior perimeter of the pit and on one edge where the depressed pit lift ramp is located. Also refer to Sheet 3/A100 for additional section cut detail. No addendum is needed for this item. Miscellaneous Metals Subcontractor to provide and install.	
BP2-012	Addendum #2	Please confirm all CMU clips per 4/S611 and similar are by the misc. metals contractor.		R

BP2-013	Addendum #2	What is the thickness of the ribbed metal pan from top of rib to bottom of rib on the 2nd floor pan deck for Slab S3?	See metal deck schedule on Sheet S322.	R
BP2-014	Addendum #2	Does this project have any DBE, WBE etc, requirements?	No it does not	R
BP2-015	Addendum #3	sections 7/8/S501 – please confirm we are to include the HSS/channel/angles shown in these sections.	The tubes depicted in those details are to be part of the Structural Steel scope. This does not apply to the steel stair stringer tubes. The tubes at the ornamental staircase are by the Misc. Metals.	R
BP2-016	Addendum #2	Confirm ALL work related prefab/light gauge canopies per sheet A1205 and similar is by others.	All non-structural canopies to be by the Miscellaneous Metals subcontractor.	R
BP2-017	Addendum #2	Confirm that no lintels are to be part of the Structural Steel Scope.	No loose lintels are to be by the Structural Steel Subcontractor.	R
BP2-018	Addendum #3	What miscellaneous metals will be required for millwork support? Please provide a drawing of these needed supports.	None. Prefabricated countertop supports will be specified to be provided by the architectural casework contractor.	R
BP2-019	Addendum #3	DRAWING 6/S 500 SHOWS WEB OPENINGS DETAIL .LOCATIONS NOT SHOWN ON S-DRAWINGS .PLEASE PROVIDE	See below for answer at BP2-030	R
BP2-020	Addendum #3	The specification's state to fasten all layers of insulation, including the cover board at the metal roof areas. Is this the desired application? The cover board should be installed in approved adhesive to eliminate the insulation fasteners coming in contact with the bottom of the EPDM membrane. This is the primary reason for using a cover board.	Coverboard is only required at the two canopy locations as shown on the drawings. The coverboard shall be mechanically fastened as specified.	R

BP2-021	Addendum #3	07 53 00 3.03 C references a LiveRoof system. I do not see this on the plans. Is there a LiveRoof system on this project?	Will be covered in BP2 Addendum 3.	R
BP2-022	Addendum #3	The details for the canopy on page A1205 show a coverboard and membrane on the metal deck with tapered at the drains only. The roof plan shows this deck as flat(129'-8" at column Line A) Notes on the roof plan state 1/8" slope. Is this a fully tapered roof area or slope in the deck?	Slope in the deck. Roof elevations were corrected under BP #2 - Addendum 2.	R
BP2-023	Addendum #3	Will there be any posts required in low height gypsum wall as indicated in the Miscellaneous Metal scope?	Yes. Only at the half wall in room 1103A. Will be covered in BP2 Addendum 3.	R
BP2-024	Addendum #3	Specification Reference 072500 requires an air barrier material to be installed at 40 dry mils. The majority of the specified products are "low mil" products and are installed at 10 dry mils. Can the WR Meadows LMP "black" fluid applied vapor permeable air barrier membrane be utilized which is installed at 40 dry mils and can be exposed to UV rays for 6 months per the specification requirements.	Will be covered in BP2 Addendum 3.	R
BP2-025	Addendum #3	Multiple sections on S501/S510 – please confirm who is supposed to include the nuts and rods? Please confirm who is to furnish and/or install the nuts and rods.	Keynote 3.375 will be provided by Building Concrete subcontractor. Keynote 5.524 will be provided by the Structural Steel subcontractor.	R
BP2-026	Addendum #3	In the Misc. Metals Package there is an Alternate no.2 on the bid form. Where is the description on that alternate listed?	Currently there is not an Alternate #2. Insert \$0 in this line	R
BP2-027	Addendum #3	Does Barrier One and the Spraylock sealer need to be added to the roof concrete as shown on page 331S & 332S?	No	R

BP2-028	Addendum #3	that all touch up painting, if required, is to be the painting contractor.	Paint touch-up by painting subcontractor. 2. Temporary wood built ladders to be by the Building Concrete subcontractor 3. Structural Steel subcontractor to provide specified primer. Paint subcontractor to ensure final finish compatibility. 4. Per 6.g. in the Structural Steel scope adjustable masonry ties provided by the Masonry subcontractor. 5. Scope states at all framed openings. 00220.206-3, 7.d to remain in scope. Please review drawings for all locations with framed openings. (stairs, elevator shaft, etc.). 6. 8.e. to remain in scope. 7. 00220.206-3, 9.a. to remain in scope. Structural drawings have addressed all the loading requirements.	R
BP2-029	Addendum #3	Does the slab on grade and 2nd floor needs to be wet cured after the installation of the Spraylock Sealer? based on the 033 30 00.02 page 9, 3.07 Curing and Protection	Conform to specifications; See specifications section 03 30 00.02; Paragraph 3.07. Spray lock is not required and has been removed from the concrete sub scope.	R
BP2-030	Addendum #3	Please advise on the following structural steel questions:  1. Who is to provide the galv. plates/epoxy anchors per 11/S500?  1a. Who is providing the galv plates per 9/10 on S510?  2. Who is providing the nuts/threaded rods per 6/S510 and similar?  Who is to install the nuts/rods?  3. Please confirm no web openings (6/S500) are required as none are specifically called out on drawings.  4. No steel prime paint specs have been provided. Is our standard Sherwin Williams water based gray prime paint sufficient?	1 and 1a. By the miscellaneous metals subcontractor who is providing the canopy. 2. Keynote 3.375 will be provided by Building Concrete subcontractor. Keynote 5.524 will be provided by the Structural Steel subcontractor. 3. At time of BP #2, no web openings are known. 4. See answer in BP-028 above.	R
BP2-031	Addendum #3	Please address the following Building Concrete questions: 1. Can you point in of the direction of where spray lock is mentioned in the specs? 2. Can we use either a curing compound or a wet cure for curing the concrete?	Spray-Lock has been removed from concrete sub scope. 2. Conform to specifications; See specifications section 03 30 00.02; Paragraph 3.07. and provide whatever is more stringent.	R
BP2-032	Addendum #3	Are there liquidated damages?     o If yes, what is the daily amount?	No liquidated damages on this project	R

BP2-033	Addendum #3	The Scissor Lift Platform seems to be a custom size. Can the size be changed to 72"x96" nominal?	The size specified is a standard size and all dimensional information was provided to Kluber by Blue Giant. You will not find the unit specified on the manufacturers web site. The unit size will remain the same.	R
BP2-034	Addendum #3	Can the electrical characteristics of the Sectional Overhead Doors specification change to 1/3 or 1/2 HP? Also can the safety edge be the pneumatic type?	No glazed lites are specified. (Is the bidder using the WRONG SPECS? This was in the DD Specs but not the ones issued with BP2). Specs will be revised to 1/2 HP motor. Safety edge will remain as specified.	R
BP2-035	Addendum #3	In the Structural Steel Package there is an Alternate no.2 on the bid form. Where is the description on that alternate listed ?	Currently there is not an Alternate #2. Insert \$0 in this line	R
BP2-036	Addendum #3	Can fly ash be utilized in the slab on grade concrete mix?	No concrete subcontractor to exlcude the use of fly ash in the slab on grade and elevated concrete deck.	R
BP2-037	Addendum #3	Who is to provide permanent elevator pit ladder?	The Elevator subcontractor to provide the permanent elevator pit ladder.	R
BP2-038	Addendum #3	3.c. in the Metal Panel work scope states "Subcontractor shall engage a qualified testing agency to perform tests and inspections to conduct water-spray testing as specified." Does this have to be a third party?	Metal Panel subcontractor to provide quality control and testing per design specification requirements.	R
BP2-039	Addendum #3	Masonry scope item 5.i.viii. States "HM Door Frames in Masonry Wall (assist Carpentry Subcontractor)" to be installed by Mason. Is this the case?		R
BP2-040	Addendum #3	Per structural steel scope safety cabling should be "engineered". Who is responsible to "engineer" safety cables? Who is going to provide, maintain and remove toe board of guardrail?	Item 7.a. to remain in Structural Steel Scope. Per the Structural Steel Scope "Toe boards shall be furnished and installed by the Concrete contractor including toe board maintenance. Removal of toe board and attachment is to be by Miscellaneous Steel subcontractor."	R

BP2-041	Addendum #5	Questions on winter/weather provisions for concrete: 1. Since the foundation work is planned for January-February. Who is responsible for keeping the open excavations from freezing? I.E. Blanketing and ground thaw machines 2. For the actual foundation working during this time is there anything other than winter blanketing required? Some areas will not let you pour in freezing temps without heating the formwork. This can be a huge expense and there is no way of knowing what the conditions may be. Normally we see an allowance set aside for this.	Foundations are to be poured immediately after foundation excavations. Building Concrete subcontractor to ensure bottom of footings must be dry prior to foundation pouring. 2. Include precautions needed for the time of year foundations will be poured.	R
BP2-042	Addendum #5	Can you confirm with the project is going to require ABAA tests and inspection costs on this project? (RE: spec section 072500 - 3.04 - B). The air barrier manufacturers rep can inspect and approve the application of the air barrier and submit written reports at no additional charge.	ABAA tests will not be required. The Specs will be revised by Addendum #5 to include manufacturer's representative inspection and approval only of a mock-up prior to full installation.	R
BP2-043	Addendum #5	Can you please clarify if we are supposed to include a bid bond with our proposals or just provide an add alternate amount for the bid bond?	A 10% bid bond is required, but a performance and payment bond is an alternate on the bid proposal forms.	R
BP2-044	Addendum #5	Details 2-4 on A1200 show gypsum board stopping at the bottom of the beam height and the space between the beam and wall system is completely filled with spray foam. Can the gypsum board go all the way to the bottom of the deck instead of stopping at the bottom of the beam height? If there is any foam not covered by gypsum board it would require a thermal barrier equivalent intumescent coating per code, but in this case it seems to be more cost effective to have the gypsum board installed all the way up than having the spray the intumescent coating.	Conform to the details on the construction documents. Intumescent is specified and anticipated at locations where the spray foam is installed and visible to view.	R
BP2-045	Addendum #5	In the Membrane Roofing Scope it states "A full-time manager/supervisor and full-time competent safety supervisor shall be present during all work. Start date and sequence to be at the direction of Leopardo superintendent." Can the foreman be the full-time competent safety supervisor as well the full-time manager during all work?	Yes the foreman can be the full time competent safety supervisor as well as the full-tiem manager during the work.	R
BP2-046	Addendum #5	Does the Barrier One Moisture Vapor Reduction Admixture need to be incorporated in the roof slabs?	No. Was answered already above.	R

BP2-047	Addendum #5	What does the FP stands for on the structural drawings? Does the spray foam at the floor beam level need to provide an R value of 21 or are the intentions to fill the beam cavity?	The FP Beams on the Structural Drawings mean that member gets fireproofing. Those beams do not get any primer on them from the fabricator so the fireproofing will stick with no additional primer needed. The spray foam needs to fill the beam cavity as shown. It is also being used for sound control (in addition to the thermal requirements) between interior room wall that intersect these areas perpendicular to the outside wall behind the beam to avoid sound transfer between rooms.	R
BP2-048	Addendum #5	If a cashier's check is being provided in lieu of a bid bond who is the check made payable to?	Will County Treasurer	R
BP2-049	Addendum #5	If a subcontractor is bidding multiple packages can one bid bond be requested for a combined total amount with the original bid bond in the more costly bid category and a copy be placed in the less costly bid category?	One bid bond may be provided for multiple bid categories with the following stipulations: 1. The bid bond or copy of the bid bond MUST be included in all sealed bid category submissions. 2. The bid bond's description states either the bid bond is for Bid Package #2 (as a general statement) or the description has all the intended bid categories listed. 3. The 10% bid bond MUST be 10% of the COMBINED total of the bid categories.	R
BP2-050	Addendum #5	Please clarify if the floor deck gets sprayed with fireproofing since the current deck is 3" decking with 3" Normal Weight concrete which does not provide a 1 hr rating.	The floor decking locations as shown in Detail 1/G301 shall get fireproofing. (Note: This is the floor deck above a portion of the large multipurpose meeting room Number 1005A & 1005B that is indicated with cross hatching). Addendum #5 fireproofing specs under Article 3.06 Schedule will be corrected to include fireproofing for the decking in the cross hatched areas).	R
BP2-051	Addendum #5	If a subcontractor has completed all these pre-qualification forms to Leopard Companies Inc. for past projects. Does a subcontractor need to resubmit the requested qualification forms again for the Will Coundy Health Department project?	Yes all subcontractors must fill out the pre-qualification forms with their sealed bid.	R

### SECTION 00 91 07 BP #2 - ADDENDUM NUMBER 5

DATE: NOVEMBER 13, 2018

PROJECT: WILL COUNTY HEALTH DEPARTMENT - NEW HEALTH DEPARTMENT

BUILDING

501 ELLA AVENUE JOLIET, ILLINOIS 60433

PROJECT NO: 17-401-1124

OWNER: THE COUNTY OF WILL

**302 NORTH CHICAGO STREET** 

**JOLIET, ILLINOIS 60432** 

TO: PROSPECTIVE BIDDERS / PLANHOLDERS OF RECORD

This Addendum forms a part of the Contract Documents and modifies the Bidding Documents For Bid Package #2 dated 10/23/2018, with amendments and additions noted below. Acknowledge receipt of this Addendum in the space provided in the Bid Form. Failure to do so may subject the Bidder to disqualification.

This Addendum consists of Three (3) pages and Drawings A330, A501, A600, A1000, A1001, A1202, A1203, A1204, S321 & S500.

#### **CHANGES TO SPECIFICATIONS**

#### 1.01 SECTION 07 25 00.02 - WEATHER BARRIERS

- A. Under Article 1.05 SUBMITTALS:
  - 1. Delete Paragraph E in its entirety.
- B. Under Article 1.06 QUALITY ASSURANCE:
  - 1. Delete Paragraph A and replace with the following:
    - "A. The air barrier factory trained representative shall conduct an inspection of the mock-up wall assembly system to review the weather barrier installation for approval and submit a written report accepting the weather barrier application on the mock-up panel prior to the contractor proceeding with the full building weather barrier installation."
- C. Under Article 3.04 FIELD QUALITY CONTROL:
  - 1. Delete Paragraph B in its entirety.

BP #2 - ADDENDUM NUMBER 5

#### 1.02 SECTION 07 81 00.02 - APPLIED FIREPROOFING

- A. Under Article 3.06 SCHEDULE:
  - 1. Add to the bottom of the Schedule the following:

"Area: \*As indicated on the drawings".

"Element/Assembly: Interior steel floor decking above Multipurpose Room 1005A & 1005B."

"Rating: 1 Hour."

"U.L. Design No.: D710."

#### **CHANGES TO THE DRAWINGS**

#### 2.01 DRAWING A330 - ROOF PLAN

- A. Detail 1/A330: Revised ACC Unit quantity to three (3) as noted (ACC-1, ACC-2 & ACC-3), roof portal and roof curb extents east of RTU-1 as clouded.
- B. Detail1/A330: Properly located all vents thru roof locations to coordinate with future Bid Package Release. Refer to revisions cloud 9.
- C. Detail 1/A330: Added roof drain tags.
- D. General Notes: Deleted General note #7.

#### 2.02 DRAWING A501 - ENLARGED PLANS

A. Detail 8/A501: Added post location dimensions for the central handrail assembly at the ornamental staircase.

#### 2.03 DRAWING A600 - BUILDING SECTIONS

A. Detail 2A/A501: Added ornamental staircase post locations and revised keynote 5.074.

#### 2.04 DRAWING A1000 - PLAN DETAILS

- A. Revisions to the weather barrier coating placement and termination points. Minor modifications to the details as noted. Refer to revision cloud 9 for specific changes.
- B. Added General Note #4.

#### 2.05 DRAWING A1001 - PLAN DETAILS

- A. Revisions to the weather barrier coating placement and termination points. Minor modifications to the details as noted. Refer to revision cloud 9 for specific changes.
- B. Added General Note #4.

#### 2.06 DRAWING A1202 - WALL SECTIONS

- A. Revisions to the weather barrier coating placement and termination points. Minor modifications to the details as noted. Refer to revision cloud 9 for specific changes.
- B. Added General Note #6.

#### 2.07 DRAWING A1203 - WALL SECTIONS

- A. Revisions to the weather barrier coating placement and termination points. Minor modifications to the details as noted. Refer to revision cloud 9 for specific changes.
- B. Added General Note #6.

#### 2.08 DRAWING A1204 - WALL SECTIONS

- A. Revisions to the weather barrier coating placement and termination points. Minor modifications to the details as noted. Refer to revision cloud 9 for specific changes.
- B. Added General Note #6.


#### 2.09 DRAWING S321 - PARTIAL SECOND FLOOR FRAMING PLAN - AREA 'A'

A. Delete drawing in its entirety and replace with drawing number S321 (attached). Refer to revision cloud 9 for specific changes.

#### 2.10 DRAWING \$500 - STANDARD FLOOR FRAMING SECTIONS AND DETAILS

A. Delete drawing in its entirety and replace with drawing number S500 (attached). Refer to revision cloud 9 for specific changes.

#### **END OF DOCUMENT**

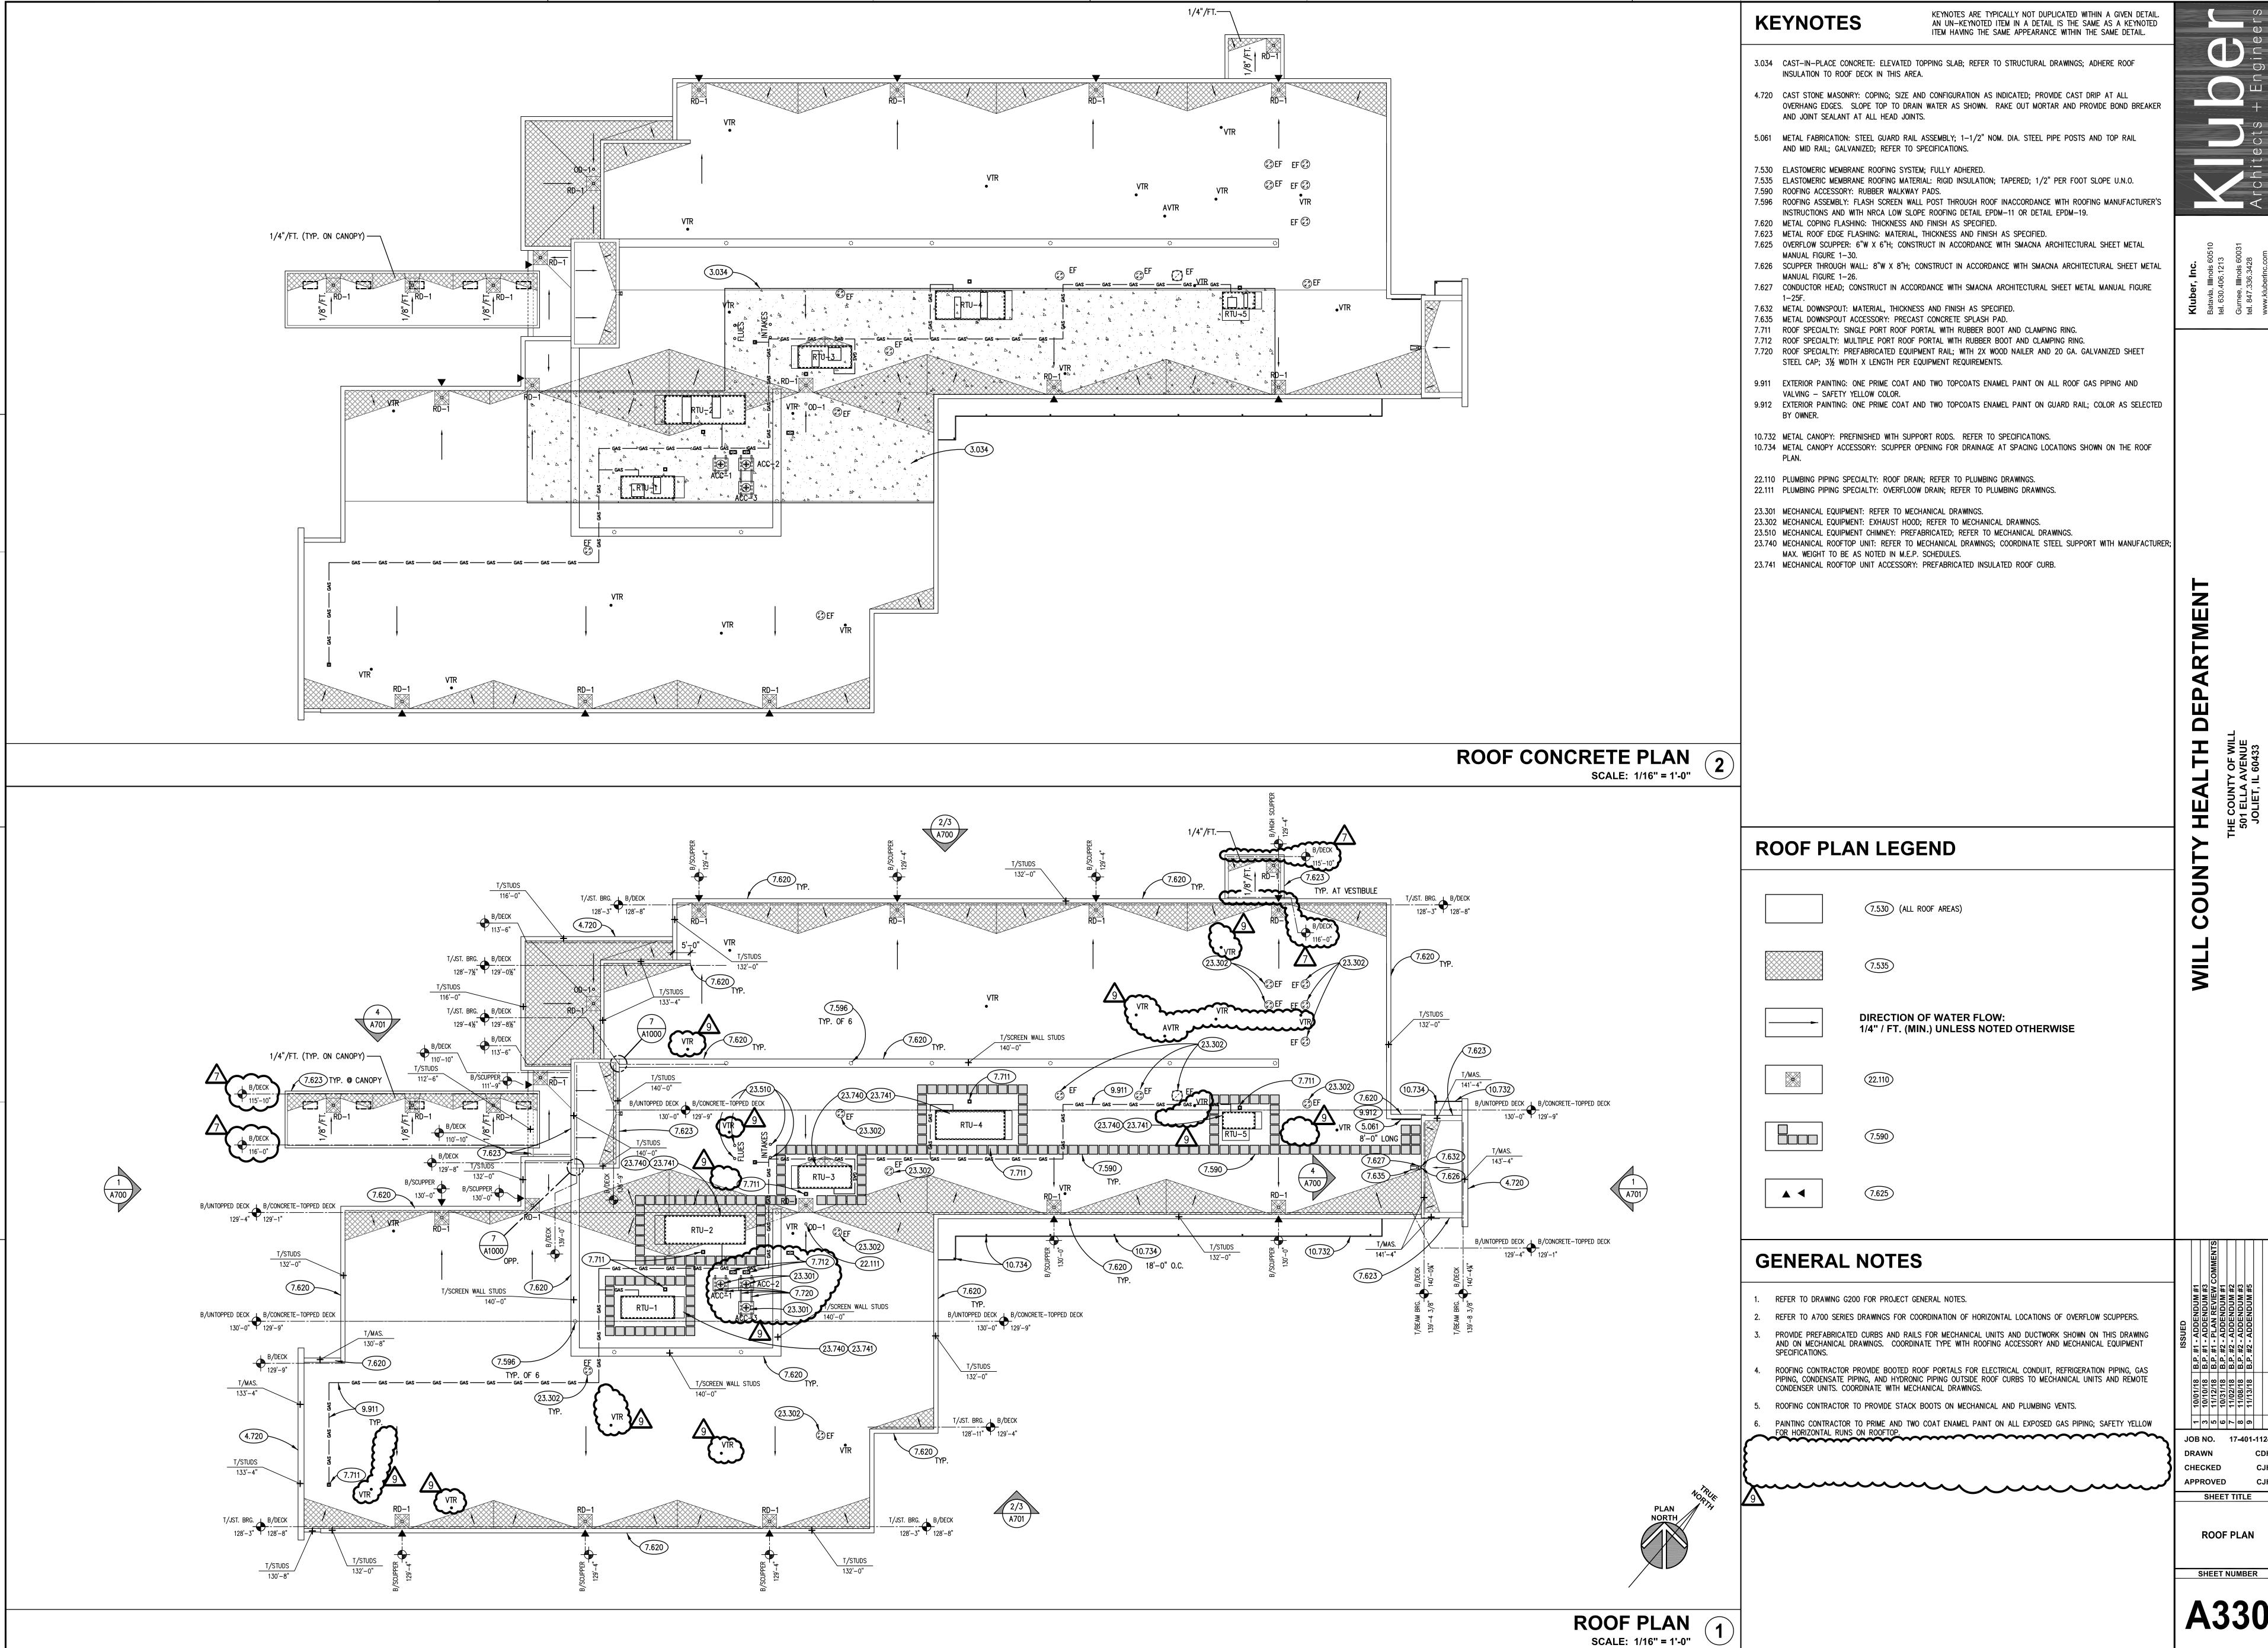

**KEYNOTES** 

1.410 30" X 48" CLEAR FLOOR SPACE FOR WHEELCHAIR.

WALL TIES; 16" O.C. VERTICAL SPACING.

FLOOR SUPPORTS @ 4'-0" O.C. MAX.

5.071 METAL FABRICATION: STEEL STAIR PAN; CONCRETE FILLED.

7.620 METAL COPING FLASHING: THICKNESS AND FINISH AS SPECIFIED. PREFORMED JOINT SEALER: REFER TO SPECIFICATIONS.

GROUND MIN. 42 INCHES DEEP.

**GENERAL NOTES** 

REFER TO DRAWING G200 FOR PROJECT GENERAL NOTES.

3.030 CAST-IN-PLACE CONCRETE: REFER TO STRUCTURAL DRAWINGS.

(MAX.); PROVIDE A MINIMUM OF 2 IN EACH BLOCKING PIECE.

4.210 BRICK MASONRY VENEER: MODULAR; RUNNING BOND; REFER TO SPECIFICATIONS.

4.194 MASONRY ACCESSORY: MORTAR DROPPING CONTROL DEVICE.

4.308 CONCRETE BLOCK MASONRY: 8" (NOM.) THK.; RUNNING BOND.

4.813 MASONRY ASSEMBLY: BRICK MASONRY EXPANSION JOINT (TYPICAL).

FORM DETECTABLE WARNING.

4.193 MASONRY ACCESSORY: WEEP VENT.

1.415 DETECTABLE WARNING: 3'-0" LONG X WIDTH OF STAIRWAY. PORCELAIN TILE CUT TO 1 INCH STRIPS TO

4.188 MASONRY ANCHORAGE AND REINFORCEMENT: ANCHOR BOLT; 1/2" DIA. X 12" LONG; HOOKED; 6'-0" O.C.

EDGE; HOLD BACK RUBBERIZED ASPHALT SHEET AT LEAST 1 INCH FROM EXTERIOR FACE OF WALL.

5.060 METAL FABRICATION: STEEL GUARD RAIL ASSEMBLY; 1-1/2" NOM. DIA. STEEL PIPE POSTS, TOP RAIL AND

5.070 METAL FABRICATION: STEEL HANDRAIL ASSEMBLY; 1 1/4" NOM. DIA. STEEL PIPE W/WALL BRACKETS OR

5.073 GLAZED DECORATIVE METAL RAILING SYSTEM WITH STAINLESS STEEL STANDOFFS DRILLED AND TAPPED TO

TREADS.

5.075 GLAZED DECORATIVE METAL RAILING SYSTEM COMPONENT: STAINLESS STEEL HANDRAIL WALL OR GLASS

OR STOREFRONT FRAMING; WELD TO UNDERSIDE OF TOP FLANGE OF STAIR STRINGER CHANNEL.

6.001 WOOD BLOCKING: DIMENSIONAL LUMBER; SIZE AS INDICATED; REFER TO SCHEDULE FOR TREATMENT.

6 X 6X W2.9 X W2.9 W.W.F. OVER 6 INCHES OF CRUSHED AND COMPACTED LIMESTONE BASE.

32.314 DECORATIVE METAL SWINGING LOUVERED GATES WITH GATE POSTS AND THROWBOLT LATCHING SET INTO

32.315 DECORATIVE METAL GATE POST: 6 X 6 FACTORY FINISHED TO MATCH GATE COLOR; CONCRETE CAST INTO

6" FROM FACE OF SCREENWALL FOUNDATION; REFER TO SPECIFICATIONS.

5.097 METAL FABRICATION: STEEL BOLLARD; 6" O.D.; CONCRETE FILLED. INSTALL 42 INCHES BELOW GRADE IN

5.092 METAL FABRICATION: 1/4" THICK STEEL PLATE; SIZE TO FIT OPENING BETWEEN STAIR STRINGER AND BACK

POSTS SPACED AS INDICATED; WELD POSTS INTO PLAIN STEEL SLEEVES; WELD SLEVES TO CHANNELS SPANNING

BETWEEN STRINGERS BENEATH TREADS AT EACH POST LOCATION PRIOR TO CONCRETE BEING POURED FOR STAIF

OF STOREFRONT FRAMING WITH GAPS OF NO MORE THAN 1/2" BETWEEN EDGE OF PLATE AND ADJACENT MASONRY

16" DIA. CONCRETE PIER AND 34 INCHES ABOVE FINISHED GRADE. PRIME AND TWO COATS ENAMEL PAINT.


SET INTO CONCRETE PIER MIN. 42 INCHES DEEP SPACED 7 FEET O.C. CENTER POSTS ADJACENT TO SCREENWALL

12'-8"

CONCRETE SLAB; GATE OPENING (2) 4'-3" WIDE GATES. TOTAL CLEAR OPENING WIDTH 9'-0"; REFER TO

BOTTOM RAIL; 3/4" DIA. BAR PICKETS AT 4.5" O.C.; REFER TO SPECIFICATIONS.

COORDINATE ELEVATION WITH BEARING CONDITIONS AND ADJACENT WALL CONSTRUCTION; BOND BEAM LENGTH

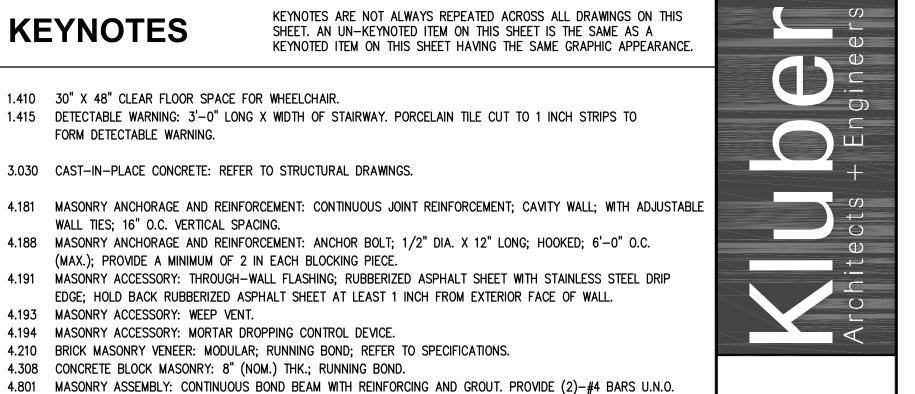

7.920 JOINT SEALANT: REFER TO SCHEDULE IN SPECIFICATION SECTION 07 92 00; PROVIDE BACKER ROD OR BOND 32.201 CAST-IN-PLACE CONCRETE: DUMPSTER PAD. PROVIDE f'c OF 4,500 PSI, 6% AIR. 6 INCHES THICK WITH 32.313 DECORATIVE METAL LOUVERED FENCING PANEL TO MATCH SWINGING GATES. 6 FEET HIGH WITH 6 x 6 POSTS

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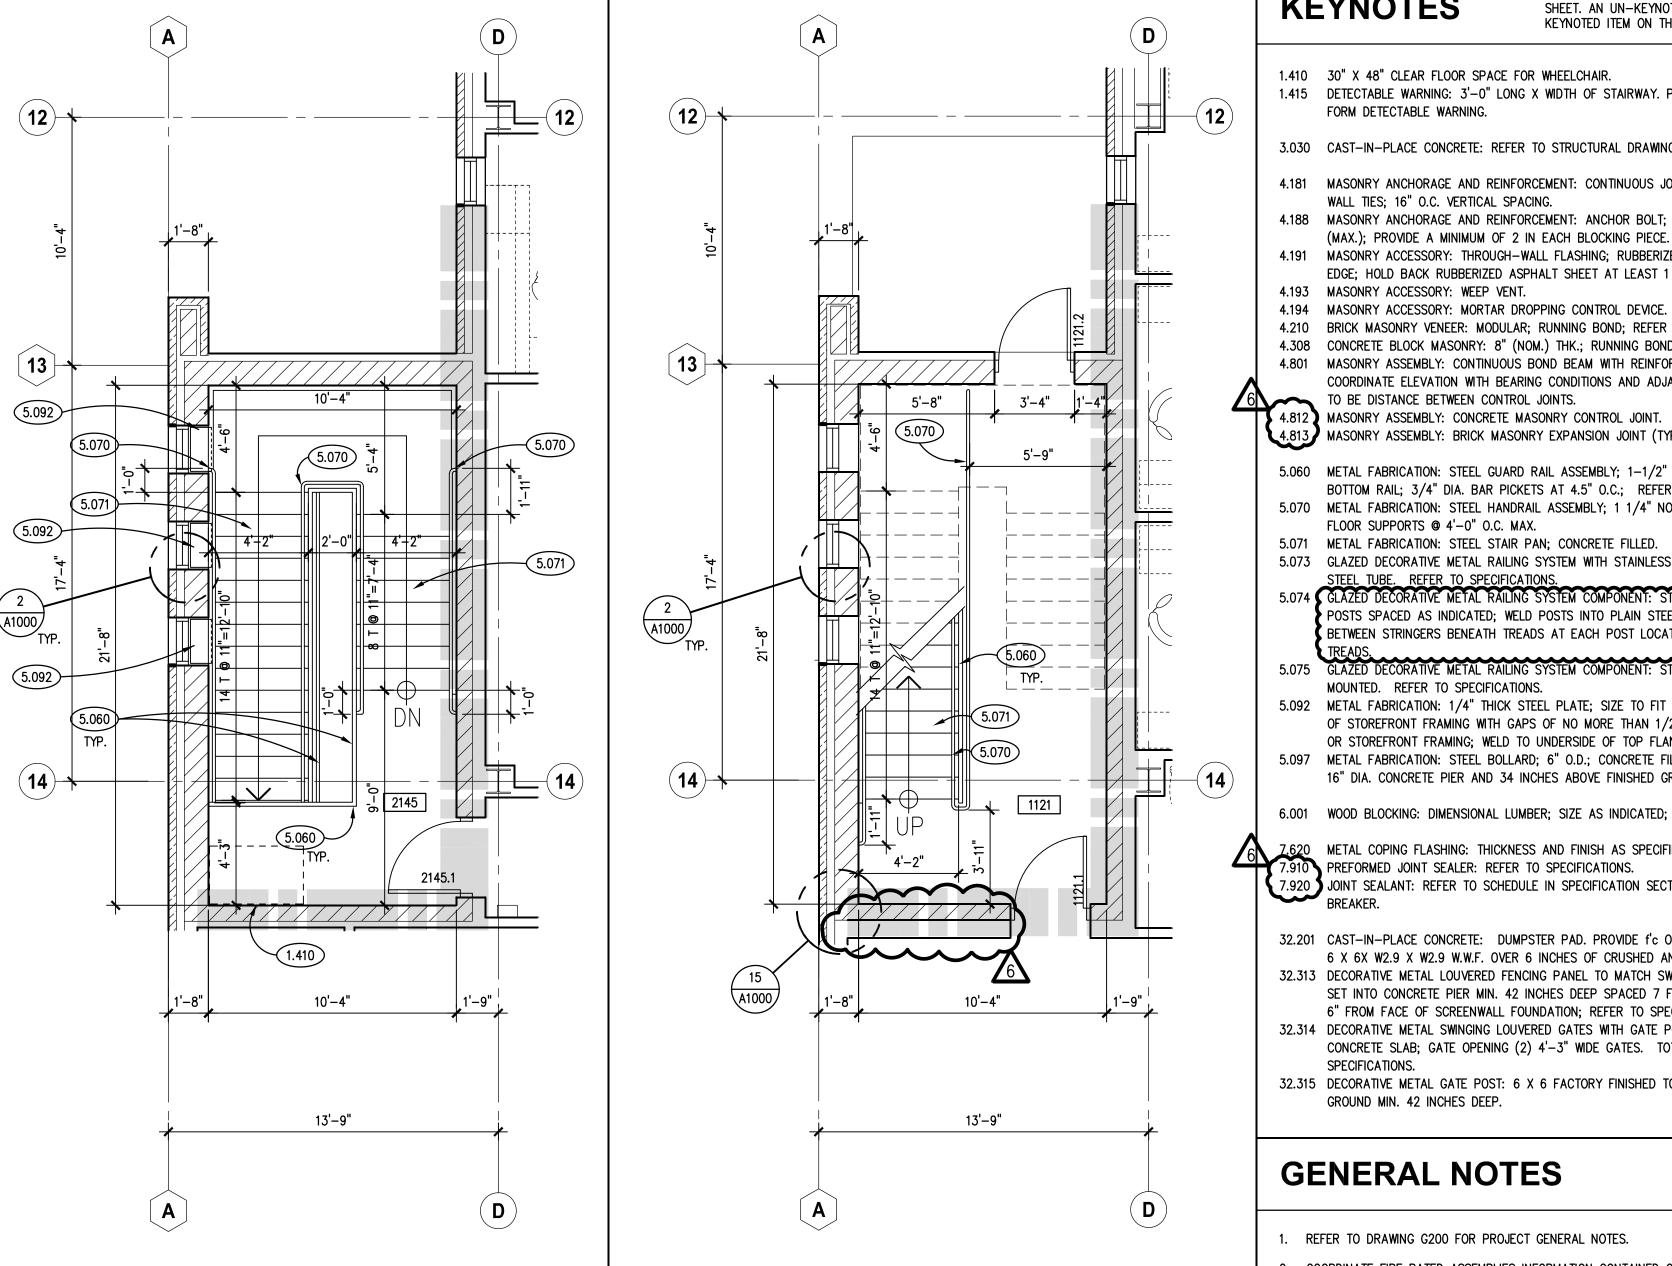
1 10/01/18 B.P.#1--3 10/10/18 B.P.#1--10/23/18 B.P.#2--5 11/12/18 B.P.#2--6 10/31/18 B.P.#2--7 11/02/18 B.P.#2--9 11/13/18 B.P.#2--

SHEET TITLE

**ENLARGED PLANS** 

SHEET NUMBER

11




WEST STAIR - SECOND FLOOR
SCALE: 1/4" = 1'-0"

5

WEST STAIR - FIRST FLOOR
SCALE: 1/4" = 1'-0"

12'-8" 7

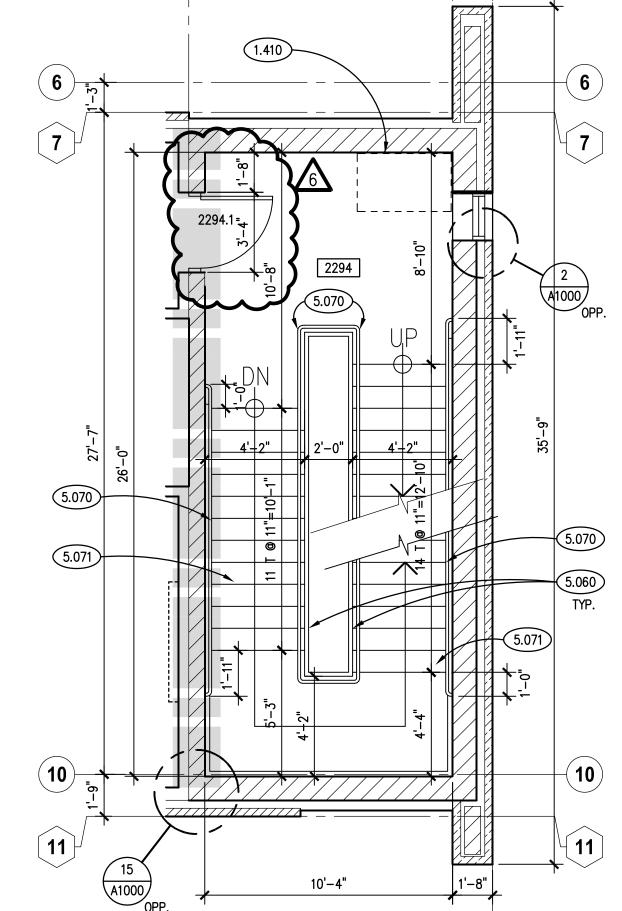

12'-8" 5.070 10'-4"

EAST STAIR - ROOF LEVEL
SCALE: 1/4" = 1'-0"

T/MASONRY 618.91' 612.91 9'-0" 9'-0" FRONT 24'-4" T/MASONRY 618.91' T/FNDN. 612.91' 
 4.812
 4.813


 7.910
 7.920
 7.620 TYPICAL SIDE TRASH ENCLOSURE ELEVATIONS
SCALE: 1/4" = 1'-0"

7

RELOCATED GLASS MARKERBOARD MONITOR

A501 11'-8" TRASH ENCLOSURE PLAN

SCALE: 1/4" = 1'-0"

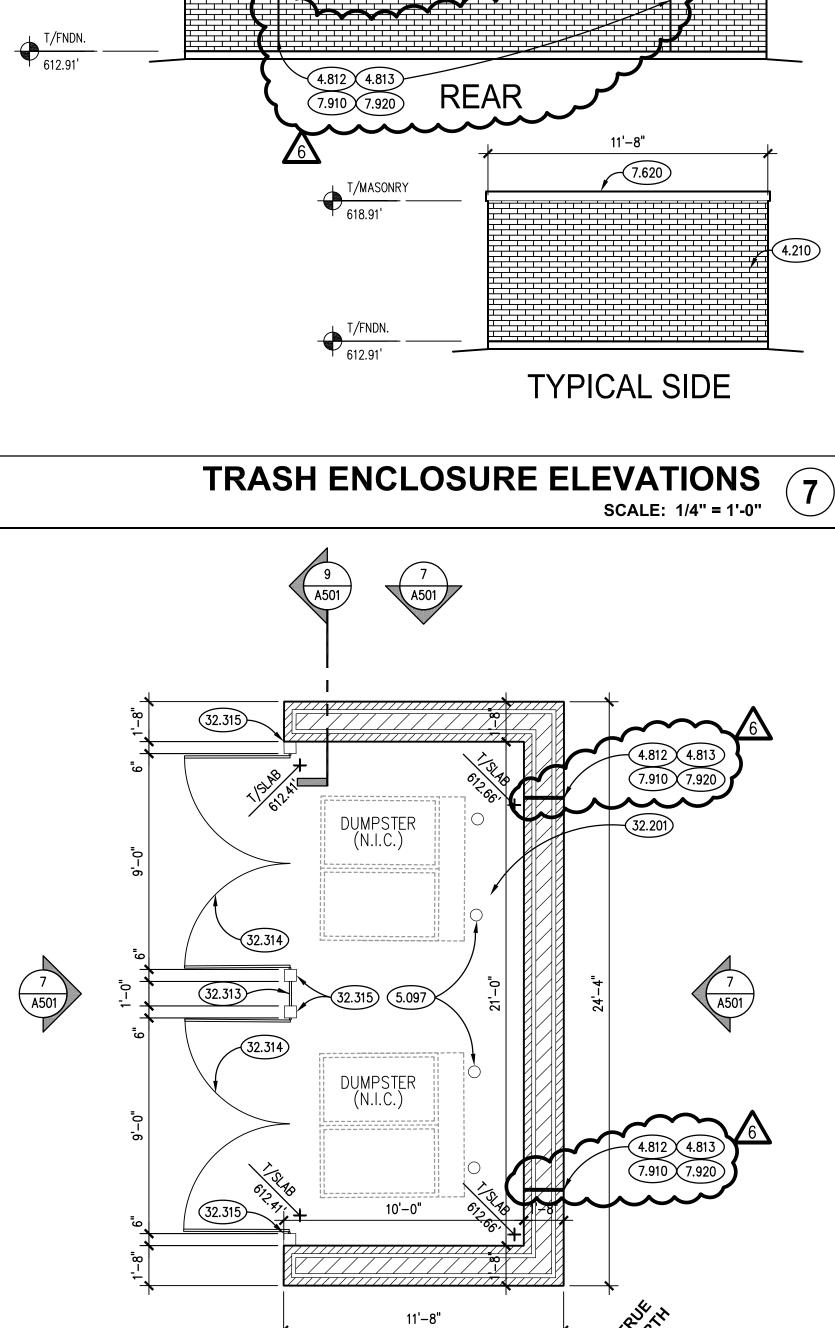

ENLARGED PLAN DETAIL - INTERIOR STAIR

SCALE: 1/4" = 1'-0"

EAST STAIR - SECOND FLOOR
SCALE: 1/4" = 1'-0"

EAST STAIR - FIRST FLOOR (1) SCALE: 1/4" = 1'-0"

TRASH ENCLOSURE WALL SECTION SCALE: 1-1/2" = 1'-0"

11

A501

PLAN DETAIL

SCALE: 1½" = 1'-0"

5

TYPICAL PLAN DETAIL

SCALE: 1½" = 1'-0"

PLAN DETAIL

SCALE: 1½" = 1'-0"

13

TYPICAL PLAN DETAIL
SCALE: 1½" = 1'-0"

9

SHEET TITLE

**PLAN DETAILS** 

A1000

KEYNOTES ARE NOT ALWAYS REPEATED ACROSS ALL DRAWINGS ON THIS

**KEYNOTES** 

SHEET. AN UN-KEYNOTED ITEM ON THIS SHEET IS THE SAME AS A KEYNOTED ITEM ON THIS SHEET HAVING THE SAME GRAPHIC APPEARANCE.

3.030 CAST-IN-PLACE CONCRETE: REFER TO STRUCTURAL DRAWINGS.

3.032 CAST-IN-PLACE CONCRETE: SLAB-ON-GRADE; REFER TO STRUCTURAL DRAWINGS FOR THICKNESS. 3.038 CAST-IN-PLACE CONCRETE ACCESSORY: RIGID BOARD INSULATION; 2" THK. MIN. R-5.4 PER INCH

THICKNESS. REFER TO SPECIFICATIONS.

4.431 STONE MASONRY VENEER: ASHLAR TYPE "SMV-1"; REFER TO SPECIFICATIONS. 4.721 CAST STONE MASONRY: SILL COURSE; SIZE AND CONFIGURATION AS INDICATED; PROVIDE CAST DRIP AT ALL OVERHANG EDGES. SLOPE TOP TO DRAIN AS SHOWN. RAKE OUT MORTAR AND PROVIDE BOND BREAKER AND

JOINT SEALANT AT ALL HEAD JOINTS. 4.722 CAST STONE MASONRY: HEADER COURSE; SIZE AND CONFIGURATION AS INDICATED; PROVIDE CAST DRIP AT ALL OVERHANG EDGES. SLOPE TOP TO DRAIN AS SHOWN. RAKE OUT MORTAR AND PROVIDE BOND BREAKER AND JOINT SEALANT AT ALL HEAD JOINTS.

5.010 STRUCTURAL STEEL: FRAMING MEMBER; REFER TO STRUCTURAL DRAWINGS.

5.030 STEEL DECK: REFER TO STRUCTURAL DRAWINGS.

5.042 COLD-FORMED METAL FRAMING: 2" Z-FURRING; HORIZONTALLY @ 24" O.C. 5.045 COLD FORMED METAL FRAMING: STUD RUNNER: SIZE TO MATCH METAL STUDS. 5.046 COLD-FORMED METAL FRAMING: 6" STUD; REFER TO STRUCTURAL DRAWINGS.

6.002 WOOD BLOCKING: DIMENSIONAL LUMBER; SIZE AS REQUIRED; REFER TO SCHEDULE FOR TREATMENT.

7.214 INSULATION: MINERAL FIBER BOARD; MIN. R-4.2 PER INCH THICKNESS; 2" THICKNESS UNLESS INDICATED OTHERWISE. 7.219 FOAMED-IN-PLACE INSULATION: THICKNESS AS REQUIRED TO ACHIEVE A MINIMUM THERMAL RESISTANCE OF

R-21 (UNLESS NOTED OTHERWISE); APPLY INTUMESCENT COATING TO ALL SURFACES NOT SEPARATED FROM THE BUILDING INTERIOR BY GYPSUM WALLBOARD. 7.251 WEATHER BARRIER COATING: SPRAY-APPLIED; REFER TO SPECIFICATIONS.

7.255 WEATHER BARRIER ACCESSORY: BASE FLASHING; 0.032" ALUMINUM; REFER TO SPECIFICATIONS. 7.420 METAL WALL PANEL SYSTEM: PREFINISHED WITH CONCEALED FASTENERS. REFER TO SPECIFICATIONS.

7.425 METAL WALL PANEL SYSTEM ACCESSORY: PREFINISHED EXTRUDED ALUMINUM SILL TRIM.

7.426 METAL WALL PANEL SYSTEM ACCESSORY: PREFINISHED EXTRUDED ALUMINUM HEAD/JAMB TRIM. 7.427 METAL WALL PANEL SYSTEM ACCESSORY: PREFINISHED EXTRUDED ALUMINUM BASE TRIM. 7.428 METAL WALL PANEL SYSTEM ACCESSORY: PREFINISHED BRAKEMETAL FLASHING: CONFIGURATION AS INDICATED

FINISH TO MATCH PANELS WHERE EXPOSED TO VIEW; SET IN CONTINUOUS SEALANT BEAD AND SEAL LAPS.
7.530 ELASTOMERIC MEMBRANE ROOFING SYSTEM; FULLY ADHERED. 7.534 ELASTOMERIC MEMBRANE ROOFING MATERIAL: RIGID INSULATION; 2 LAYERS; 3 INCH OVER 2½ INCH; 5½ 291

7.920 JOINT SEALANT: REFER TO SCHEDULE IN SPECIFICATION SECTION 07 92 00; PROVIDE BACKER ROD OR BOND BREAKER.

8.422 AUTOMATIC ENTRANCE: POWERED SLIDING DOOR SYSTEM WITH BREAKAWAY FUNCTION.

8.430 ALUMINUM STOREFRONT FRAMING. 8.437 ALUMINUM STOREFRONT ACCESSORY: 0.032" SHEET ALUMINUM HEAD/JAMB FLASHING; FINISH TO MATCH STOREFRONT FRAMING; SET IN CONTINUOUS SEALANT BEAD AND SEAL LAPS.

8.440 ALUMINUM CURTAIN WALL FRAMING.

8.445 ALUMINUM CURTAIN WALL ACCESSORY: 0.040" SHEET ALUMINUM SILL FLASHING; FINISH TO MATCH CURTAIN WALL FRAMING; SET IN CONTINUOUS SEALANT BEAD AND SEAL LAPS.

8.447 ALUMINUM CURTAIN WALL ACCESSORY: 0.032" SHEET ALUMINUM HEAD/JAMB FLASHING; FINISH TO MATCH CURTAIN WALL FRAMING; SET IN CONTINUOUS SEALANT BEAD AND SEAL LAPS.

9.209 GYPSUM BOARD: 5/8" THK.; EXTERIOR GRADE, GLASS MAT FACED. 9.210 GYPSUM BOARD: 5/8" THICK; TYPE "X".

INCHES TOTAL THICKNESS; R-30.8 (MIN).

9.217 GYPSUM BOARD ACCESSORY: CORNER BEAD. 9.223 METAL STUD FRAMING: 3-5/8" STUD; 16" O.C. SPACING; 20 GAUGE UNLESS NOTED OTHERWISE; ANCHORAGE

9.226 METAL STUD FRAMING: 6" STUD; 16" O.C. SPACING; 20 GAUGE UNLESS NOTED OTHERWISE; ANCHORAGE TO

12.368 COUNTERTOP: SOLID SURFACE WINDOW SILL; 1/2" EDGE THICKNESS WITH 11/2" PROJECTION; 1/4" RADIUS TOP EDGE, AND 1/2" THICK X 2" HIGH APRON BENEATH, U.N.O.

## **GENERAL NOTES**

REFER TO DRAWING G200 FOR PROJECT GENERAL NOTES.

COORDINATE FIRE RATED ASSEMBLIES INFORMATION CONTAINED ON DRAWING G301 & G302 WITH THE WORK OF ALL

 IN METAL STUD/GYPSUM BOARD PARTITIONS, WALLS AND CEILINGS, PROVIDE 2X FIRE RETARDANT TREATED WOOD BLOCKING FOR WALL—MOUNTED & CEILING—MOUNTED ITEMS REQUIRING MECHANICAL ANCHORAGE.
 WHERE DETAILS REQUIRE JOINT SEALANT TO SEAL WEATHER BARRIER COATING TO ADJACENT CONSTRUCTION AT OPENINGS AND PENETRATIONS, PROVIDE BOND TESTING TO PROVE THAT JOINT SEALANT BONDS ADEQUATELY TO WEATHER BARRIER COATING, OR PROVIDE 0.032" ALUMINUM CORNER FLASHING, SEALED TO WEATHER BARRIER.

10/01/18 B.P. #1 - 10/10/18 B.P. #1 - 11/12/18 B.P. #1 - 10/31/18 B.P. #2 - 11/02/18 B.P. #2 - 11/08/18 B.P. #2 - 11/13/18 B.P. JOB NO. 17-401-1124 DRAWN CHECKED **APPROVED** 


SHEET TITLE

UM #1 UM #1 UM #2 UM #3 UM #5


WALL SECTIONS

SHEET NUMBER

A1202

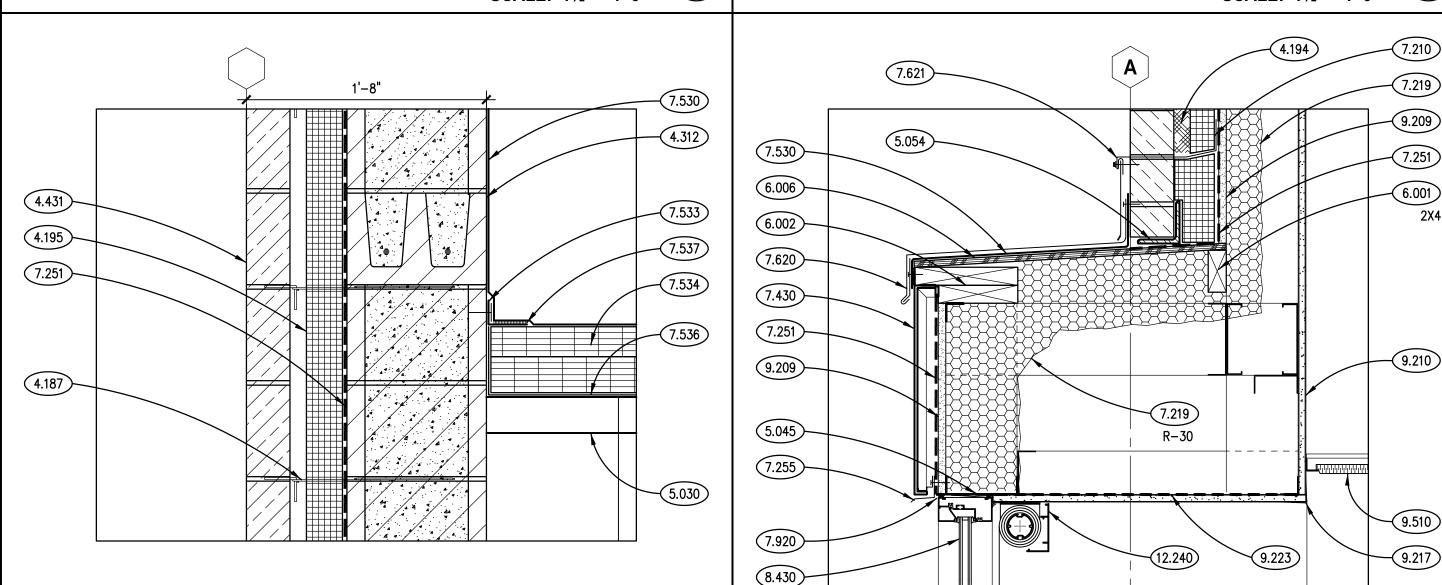

7.622 9.209 7.538 7.219 (6.006)-7.537)-7.533 -(5.045) 7.530 -(5.047) 7.534

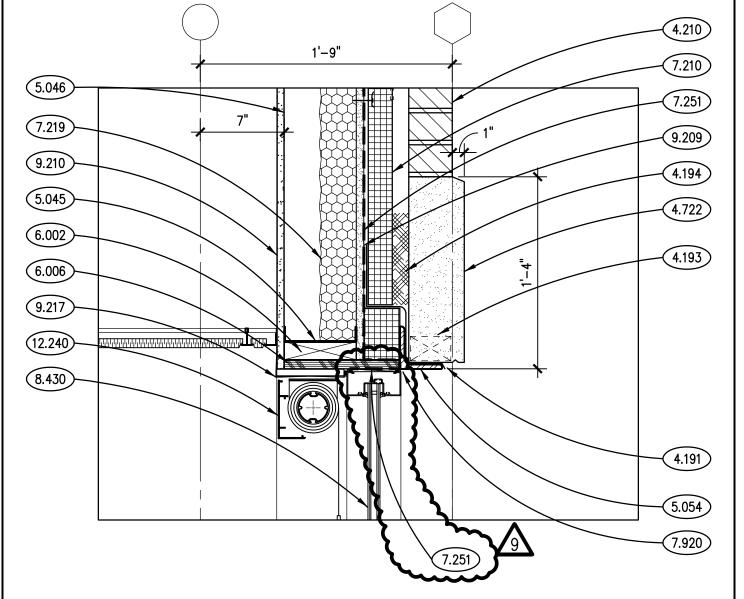

TYPICAL SECTION DETAIL

SCALE: 1½" = 1'-0"

## 5.081 METAL FABRICATION: STEEL ANGLE; REFER TO STRUCTURAL DRAWINGS. 6.001 WOOD BLOCKING: DIMENSIONAL LUMBER; SIZE AS INDICATED; REFER TO SCHEDULE FOR TREATMENT. 6.002 WOOD BLOCKING: DIMENSIONAL LUMBER; SIZE AS REQUIRED; REFER TO SCHEDULE FOR TREATMENT. 6.006 PLYWOOD: 1/2" THICK; REFER TO SPECIFICATIONS FOR TREATMENT. 7.210 INSULATION: BOARD; EXTRUDED POLYSTYRENE (XPS); MIN. R-5.4 PER INCH THICKNESS; 2" THICKNESS UNLESS INDICATED OTHERWISE. 7.214 INSULATION: MINERAL FIBER BOARD; MIN. R-4.2 PER INCH THICKNESS; 2" THICKNESS UNLESS INDICATED 7.219 FOAMED-IN-PLACE INSULATION: THICKNESS AS REQUIRED TO ACHIEVE A MINIMUM THERMAL RESISTANCE OF R-21 (UNLESS NOTED OTHERWISE); APPLY INTUMESCENT COATING TO ALL SURFACES NOT SEPARATED FROM THE BUILDING INTERIOR BY GYPSUM WALLBOARD. 7.251 WEATHER BARRIER COATING: SPRAY-APPLIED; REFER TO SPECIFICATIONS 7.255 WEATHER BARRIER ACCESSORY: BASE FLASHING; 0.032" ALUMINUM; REFER TO SPECIFICATIONS. 7.420 METAL WALL PANEL SYSTEM: PREFINISHED WITH CONCEALED FASTENERS. REFER TO SPECIFICATIONS. 7.427 METAL WALL PANEL SYSTEM ACCESSORY: PREFINISHED EXTRUDED ALUMINUM BASE TRIM. 7.430 METAL COMPOSITE PANEL SYSTEM: PREFINISHED WITH CONCEALED FASTENERS. REFER TO SPECIFICATIONS.

7.530 ELASTOMERIC MEMBRANE ROOFING SYSTEM; FULLY ADHERED. ELASTOMERIC MEMBRANE ROOFING MATERIAL: FLEXIBLE EPDM FLASHING. 7.534 ELASTOMERIC MEMBRANE ROOFING MATERIAL: RIGID INSULATION; 2 LAYERS; 3 INCH OVER 2½ INCH; 5½

7.537 ELASTOMERIC MEMBRANE ROOFING MATERIAL: ADHESIVE.

7.621 METAL COUNTERFLASHING RECEIVER: EMBEDDED IN MASONRY; MATERIAL, THICKNESS AND FINISH AS SPECIFIED.

7.622 METAL COUNTERFLASHING: MATERIAL, THICKNESS AND FINISH AS SPECIFIED. 7.842 FIRESAFING: REFER TO SPECIFICATIONS. 7.920 JOINT SEALANT: REFER TO SCHEDULE IN SPECIFICATION SECTION 07 92 00; PROVIDE BACKER ROD OR BOND

8.430 ALUMINUM STOREFRONT FRAMING.


8.435 ALUMINUM STOREFRONT ACCESSORY: 0.040" SHEET ALUMINUM SILL FLASHING; FINISH TO MATCH STOREFRONT


9.209 GYPSUM BOARD: 5/8" THK.; EXTERIOR GRADE, GLASS MAT FACED. 9.210 GYPSUM BOARD: 5/8" THICK; TYPE "X".

9.217 GYPSUM BOARD ACCESSORY: CORNER BEAD. 9.223 METAL STUD FRAMING: 3-5/8" STUD; 16" O.C. SPACING; 20 GAUGE UNLESS NOTED OTHERWISE; ANCHORAGE TO SUIT APPLICATION. 9.510 ACOUSTICAL CEILING PANELS AND GRID. REFER TO A900 SERIES DRAWINGS AND SPECIFICATIONS.

12.240 ROLLER WINDOW SHADES: MANUALLY OPERATED.

12.368 COUNTERTOP: SOLID SURFACE WINDOW SILL; 1/2" EDGE THICKNESS WITH 11/2" PROJECTION; 1/4" RADIUS TOP EDGE, AND 1/2" THICK X 2" HIGH APRON BENEATH, U.N.O.

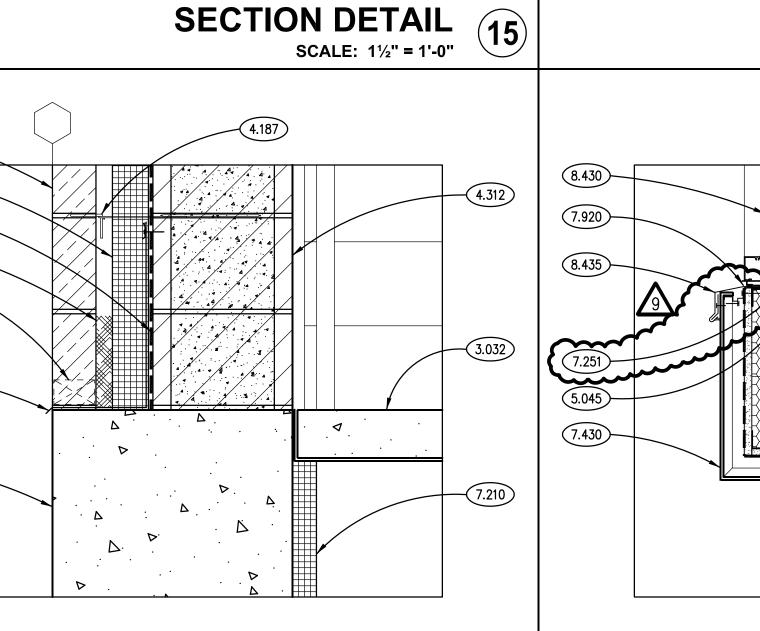


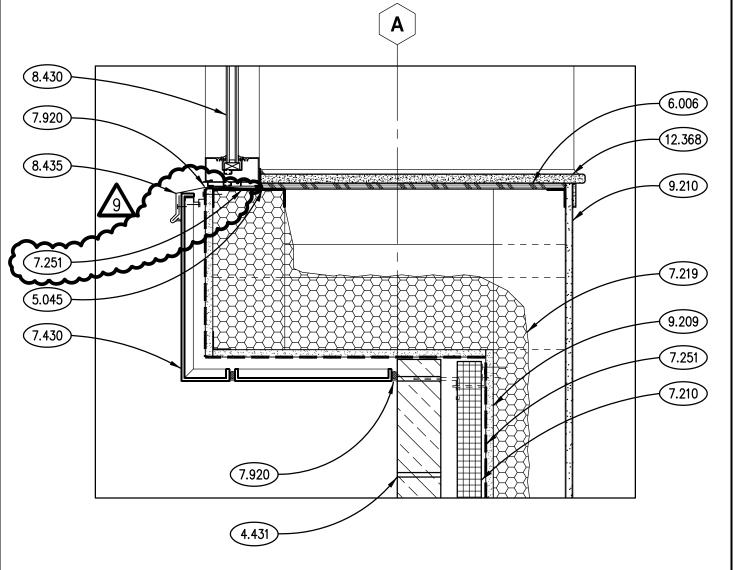


SECTION DETAIL
SCALE: 1½" = 1'-0"

SECTION DETAIL (10)

SCALE: 11/2" = 1'-0"

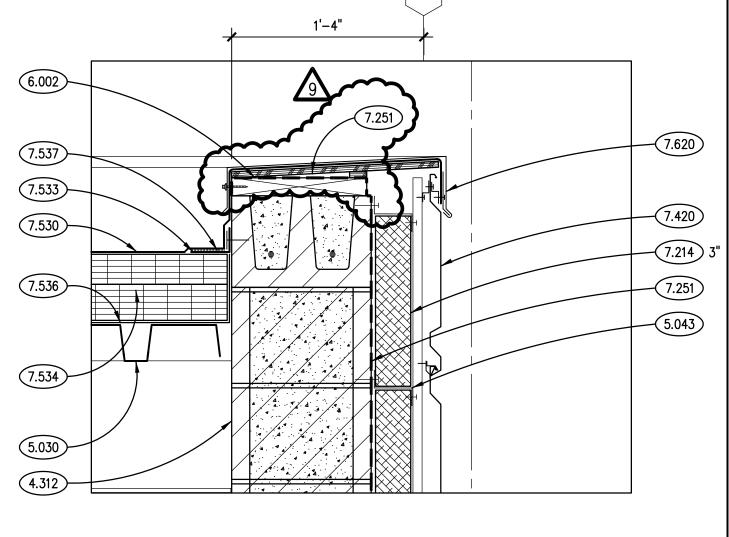

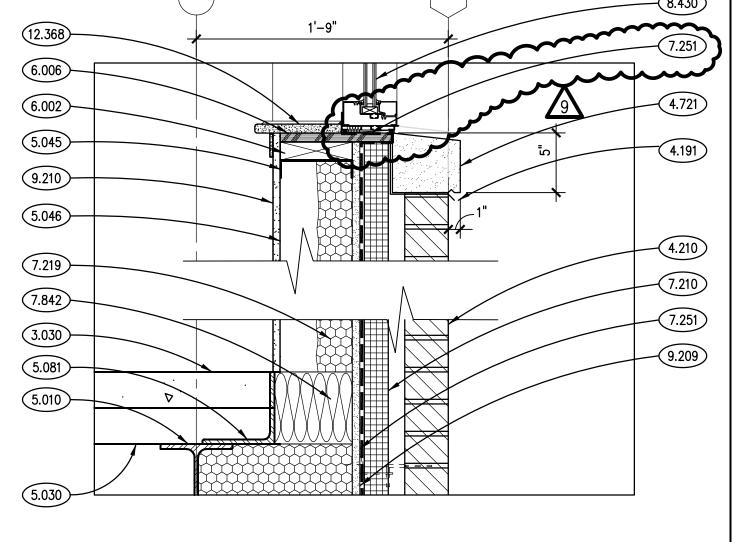

# SECTION DETAIL SCALE: 1½" = 1'-0" 6

SECTION DETAIL
SCALE: 1½" = 1'-0"

7




4.183






COORDINATE FIRE RATED ASSEMBLIES INFORMATION CONTAINED ON DRAWING G301 & G302 WITH THE WORK OF ALL

IN METAL STUD/GYPSUM BOARD PARTITIONS, WALLS AND CEILINGS, PROVIDE 2X FIRE RETARDANT TREATED WOOD BLOCKING FOR WALL-MOUNTED & CEILING-MOUNTED ITEMS REQUIRING MECHANICAL ANCHORAGE.

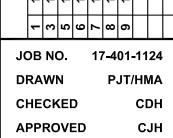

SHEET TITLE

A1203

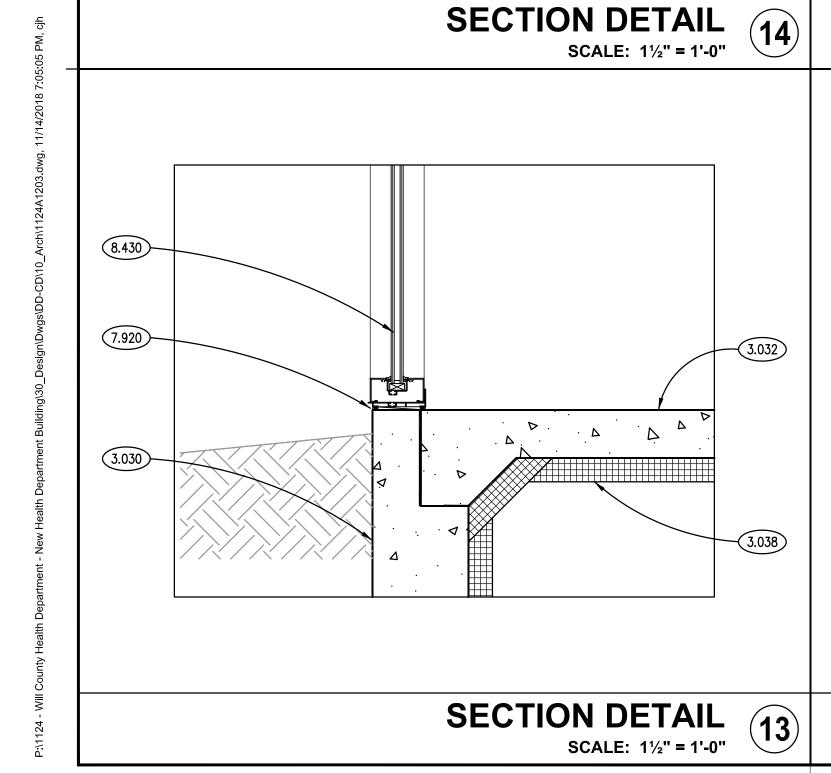

4.431

4.195


7.251

4.194

4.193

4.191


3.030

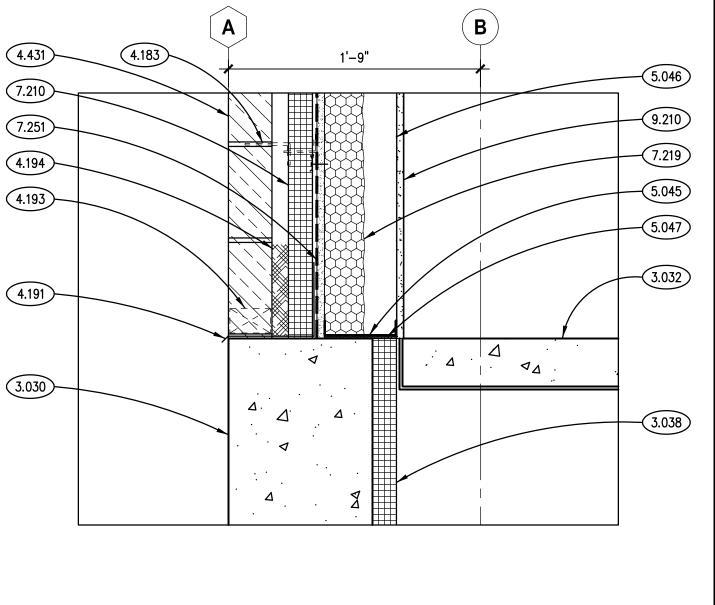


TYPICAL SECTION DETAIL

SCALE: 1½" = 1'-0"

9

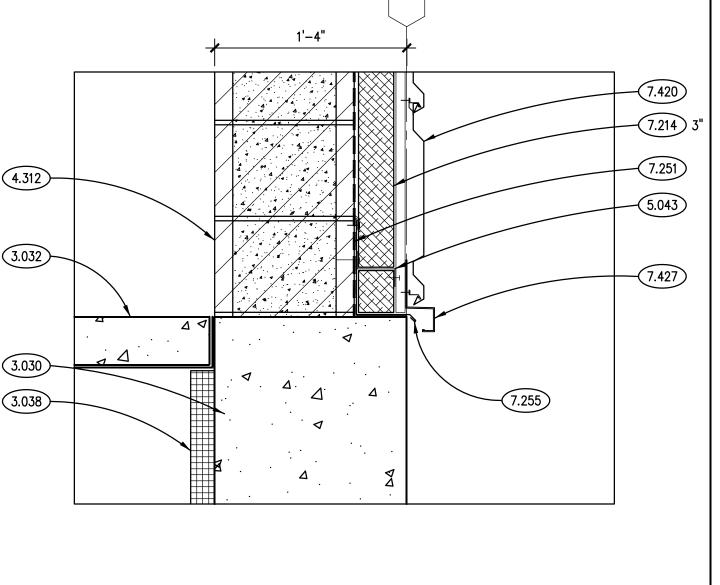

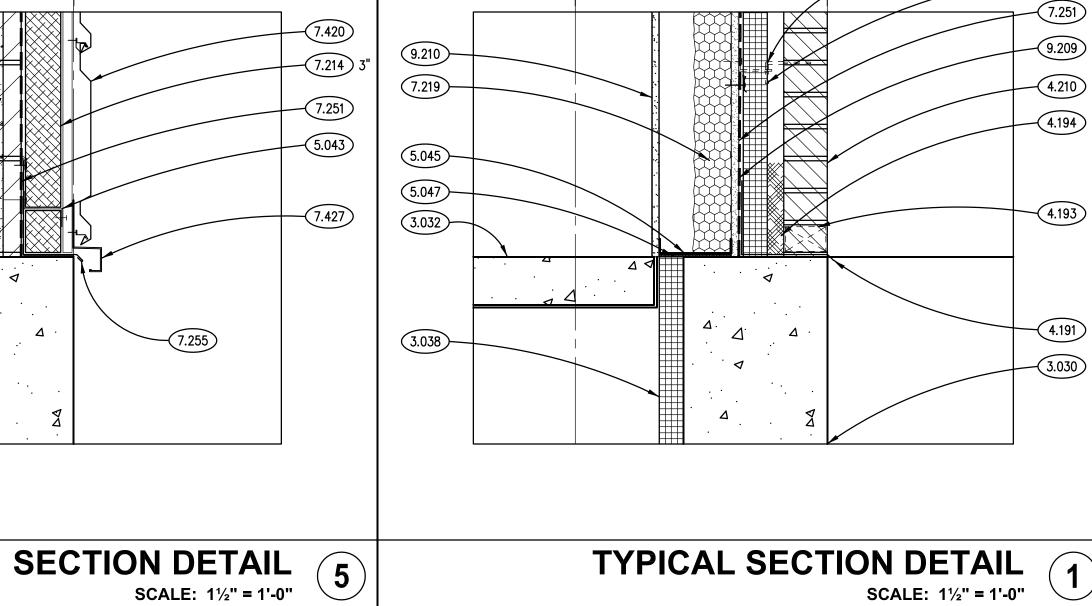

1'-9"

TYPICAL SECTION DETAIL SCALE: 1½" = 1'-0"

REFER TO A600 SERIES BUILDING SECTION DRAWINGS FOR TOP OF FLOOR AND TOP OF MASONRY ELEVATIONS.

REFER TO STRUCTURAL LINTEL DRAWINGS FOR BOTTOM OF LINTEL ELEVATIONS.

WHERE DETAILS REQUIRE JOINT SEALANT TO SEAL WEATHER BARRIER COATING TO ADJACENT CONSTRUCTION AT OPENINGS AND PENETRATIONS, PROVIDE BOND TESTING TO PROVE THAT JOINT SEALANT BONDS ADEQUATELY TO WEATHER BARRIER COATING, OR PROVIDE 0.032" ALUMINUM CORNER FLASHING, SEALED TO WEATHER BARRIER.

10/01/18 B.P. #1 - 1 10/10/18 B.P. #1 - 1 11/12/18 B.P. #1 - 1 10/31/18 B.P. #2 - 1 11/02/18 B.P. #2 - 1 11/13/18 B.P. #2 - 1

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**SECTION DETAILS** 

SHEET NUMBER

SHEET. AN UN-KEYNOTED ITEM ON THIS SHEET IS THE SAME AS A

KEYNOTED ITEM ON THIS SHEET HAVING THE SAME GRAPHIC APPEARANCE.

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REVIEW #


10/01/18 B.P. #1--1 10/10/18 B.P. #1--1 11/12/18 B.P. #1--1 10/31/18 B.P. #2--1 11/02/18 B.P. #2--1 11/13/18 B.P. #2--1

1-829-86

SHEET TITLE

**SECTION DETAILS** 

SHEET NUMBER A1204

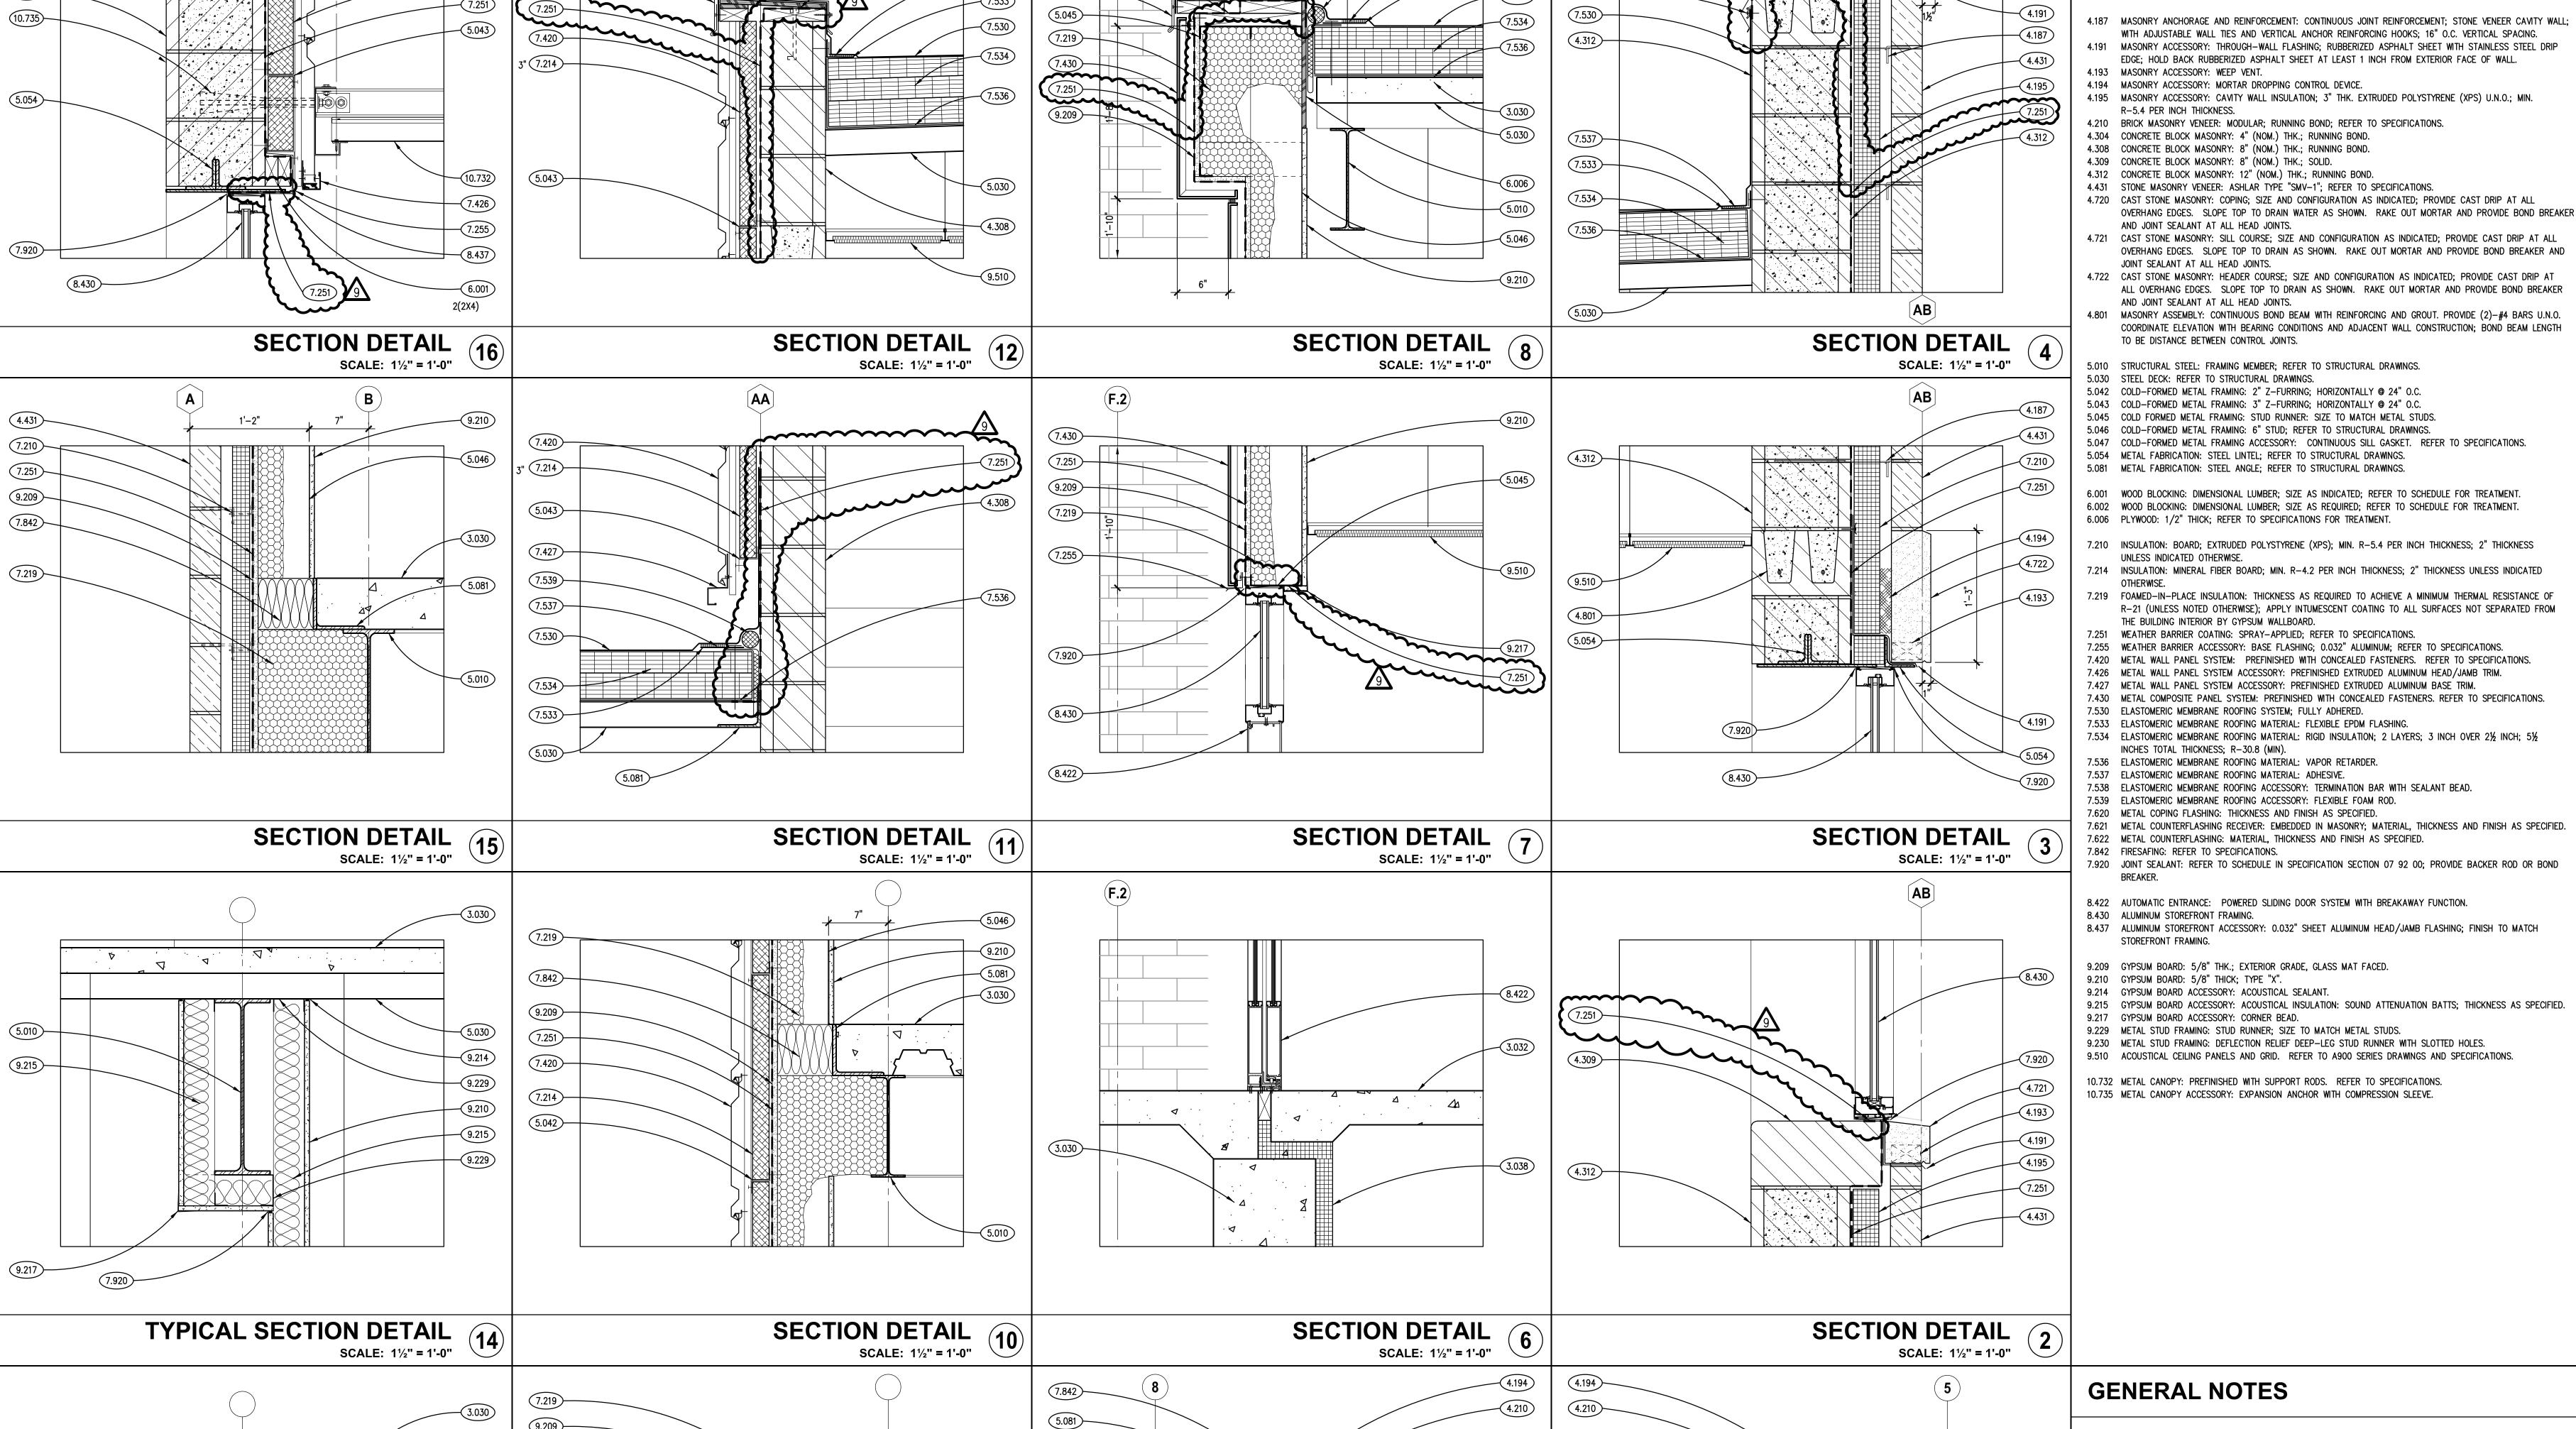

(7.210)-

9.209

7.251)-

4.304

5.010

5.046

5.081

5.045

5.047

3.032

SECTION DETAIL
SCALE: 11/2" = 1'-0"

(F.2)

(6.002)-

(7.620)—

7.533

-(7.420)

<del>-(7.214)</del> 3

4.312

7.620

7.251)-

9.209

7.251

7.420

5.042

. 4 b .

TYPICAL SECTION DETAIL
SCALE: 1½" = 1'-0"

13

5.010

(9.215)—

9.230

1'-10"

## **GENERAL NOTES**

**KEYNOTES** 

3.030 CAST-IN-PLACE CONCRETE: REFER TO STRUCTURAL DRAWINGS

THICKNESS. REFER TO SPECIFICATIONS.

AND JOINT SEALANT AT ALL HEAD JOINTS.

AND JOINT SEALANT AT ALL HEAD JOINTS.

TO BE DISTANCE BETWEEN CONTROL JOINTS.

UNLESS INDICATED OTHERWISE.

THE BUILDING INTERIOR BY GYPSUM WALLBOARD.

JOINT SEALANT AT ALL HEAD JOINTS.

R-5.4 PER INCH THICKNESS.

3.032 CAST-IN-PLACE CONCRETE: SLAB-ON-GRADE; REFER TO STRUCTURAL DRAWINGS FOR THICKNESS.

3.038 CAST-IN-PLACE CONCRETE ACCESSORY: RIGID BOARD INSULATION; 2" THK. MIN. R-5.4 PER INCH

WITH ADJUSTABLE WALL TIES AND VERTICAL ANCHOR REINFORCING HOOKS; 16" O.C. VERTICAL SPACING.

OVERHANG EDGES. SLOPE TOP TO DRAIN WATER AS SHOWN. RAKE OUT MORTAR AND PROVIDE BOND BREAKER

OVERHANG EDGES. SLOPE TOP TO DRAIN AS SHOWN. RAKE OUT MORTAR AND PROVIDE BOND BREAKER AND

ALL OVERHANG EDGES. SLOPE TOP TO DRAIN AS SHOWN. RAKE OUT MORTAR AND PROVIDE BOND BREAKER

COORDINATE ELEVATION WITH BEARING CONDITIONS AND ADJACENT WALL CONSTRUCTION; BOND BEAM LENGTH

R-21 (UNLESS NOTED OTHERWISE); APPLY INTUMESCENT COATING TO ALL SURFACES NOT SEPARATED FROM

EDGE; HOLD BACK RUBBERIZED ASPHALT SHEET AT LEAST 1 INCH FROM EXTERIOR FACE OF WALL.

1'-11"

7.539

<del>--(7.537)</del>

-(7.533)

7.530

7.621

7.622

7.538

-(7.530)

SECTION DETAIL

SCALE: 1½" = 1'-0"

5

7.210

7.622

7.538

4.304

7.537

7.530

7.534

7.536

3.030

7.251

**SECTION DETAIL** 

SCALE: 1½" = 1'-0"

7.622

7.538



- COORDINATE FIRE RATED ASSEMBLIES INFORMATION CONTAINED ON DRAWING G301 & G302 WITH THE WORK OF ALL
- REFER TO A600 SERIES BUILDING SECTION DRAWINGS FOR TOP OF FLOOR AND TOP OF MASONRY ELEVATIONS.
- REFER TO STRUCTURAL LINTEL DRAWINGS FOR BOTTOM OF LINTEL ELEVATIONS.
- IN METAL STUD/GYPSUM BOARD PARTITIONS, WALLS AND CEILINGS, PROVIDE 2X FIRE RETARDANT TREATED WOOD BLOCKING FOR WALL-MOUNTED & CEILING-MOUNTED ITEMS REQUIRING MECHANICAL ANCHORAGE.
- WHERE DETAILS REQUIRE JOINT SEALANT TO SEAL WEATHER BARRIER COATING TO ADJACENT CONSTRUCTION AT OPENINGS AND PENETRATIONS, PROVIDE BOND TESTING TO PROVE THAT JOINT SEALANT BONDS ADEQUATELY TO WEATHER BARRIER COATING, OR PROVIDE 0.032" ALUMINUM CORNER FLASHING, SEALED TO WEATHER BARRIER.